


# HILLCREST SPRING ASSISTED LIVING FACILITY SITE PLAN

**5044 & 5052 NEW YORK STATE ROUTE 20** 

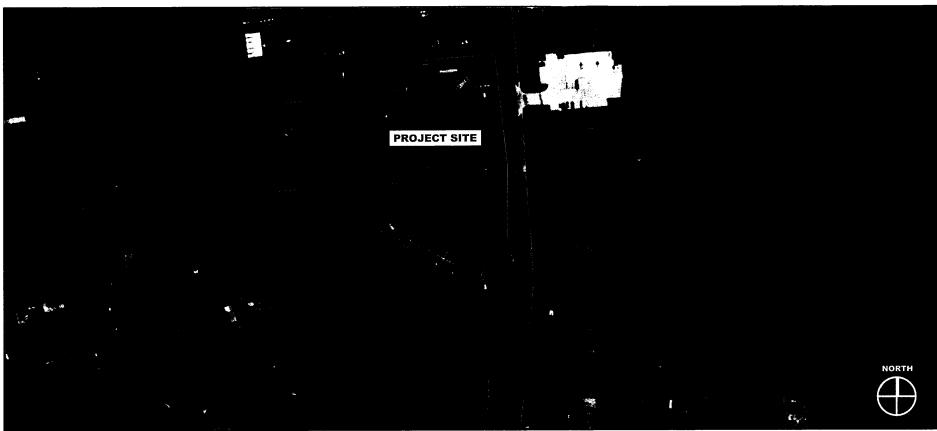

	DRAWING LIST	
SHEET ID	SHEET TITLE	SHEET NUMBER
G-001	COVER SHEET	01
C-101	EXISTING CONDITIONS	02
C-102	OVERALL SITE PLAN	03
C-103	LANDSCAPING PLAN	04
C-104	ENTRANCE PLAN	05
C-501	SITE DETAILS AND NOTES	06
C-701	TRAFFIC AND MAINTENANCE CONTROL DETAILS	07
C-702	TRAFFIC AND MAINTENANCE CONTROL DETAILS	08
C-703	TRAFFIC AND MAINTENANCE CONTROL DETAILS	09

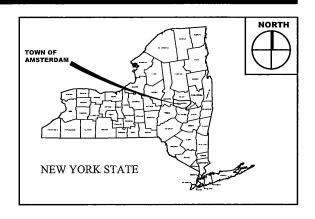

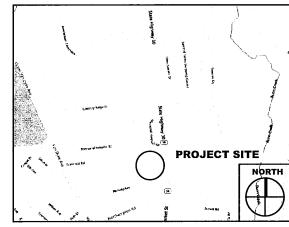

SITE LOCATION MAP

© 2022

WARNING; IT IS A VIOLATION OF THE LAW YOR MAY PRESON, UNILES ACLING UNDER THE DIRECTION OF A LICENSED AGENTECT, TO ALTER AN ITEM IN ARY MAY. IF AN HE DIRECTION DISTRICT OF ALTERNATION OF A LICENSED AND A LICENSED A

WARNING: IT IS A VIOLATION OF THIS LAW FOR ANY PERSON, UNLESS HE IS ACTING UNDER THE DISECTION OF A LICENSEY PROFESSIONAL REINIERS ON LAW SURVEYOR, TO ALTER AN ITEM IN AFT WAY. IN ATTEM BERINGS THE SCAL, OF AN BENGINERS OF A PART OF A PROPERTY OF A PART OF THE THE SCAL AND THE

## C.T. MALE ASSOCIATES

Engineering, Surveying, Architecture, Landscape Architecture & Geology, D.P.C.


50 CENTURY HILL DRIVE, LATHAM, NY 518.786.7400 COBLESKILL, NY • GLENS FALLS, NY • POUGHKEEPSIE, NY JOHNSTOWN, NY • RED HOOK, NY • SYRACUSE, NY





PROJECT NO. 20.0204 DRAWING NO. 22-0469


G-001

HEET 01 OF 13

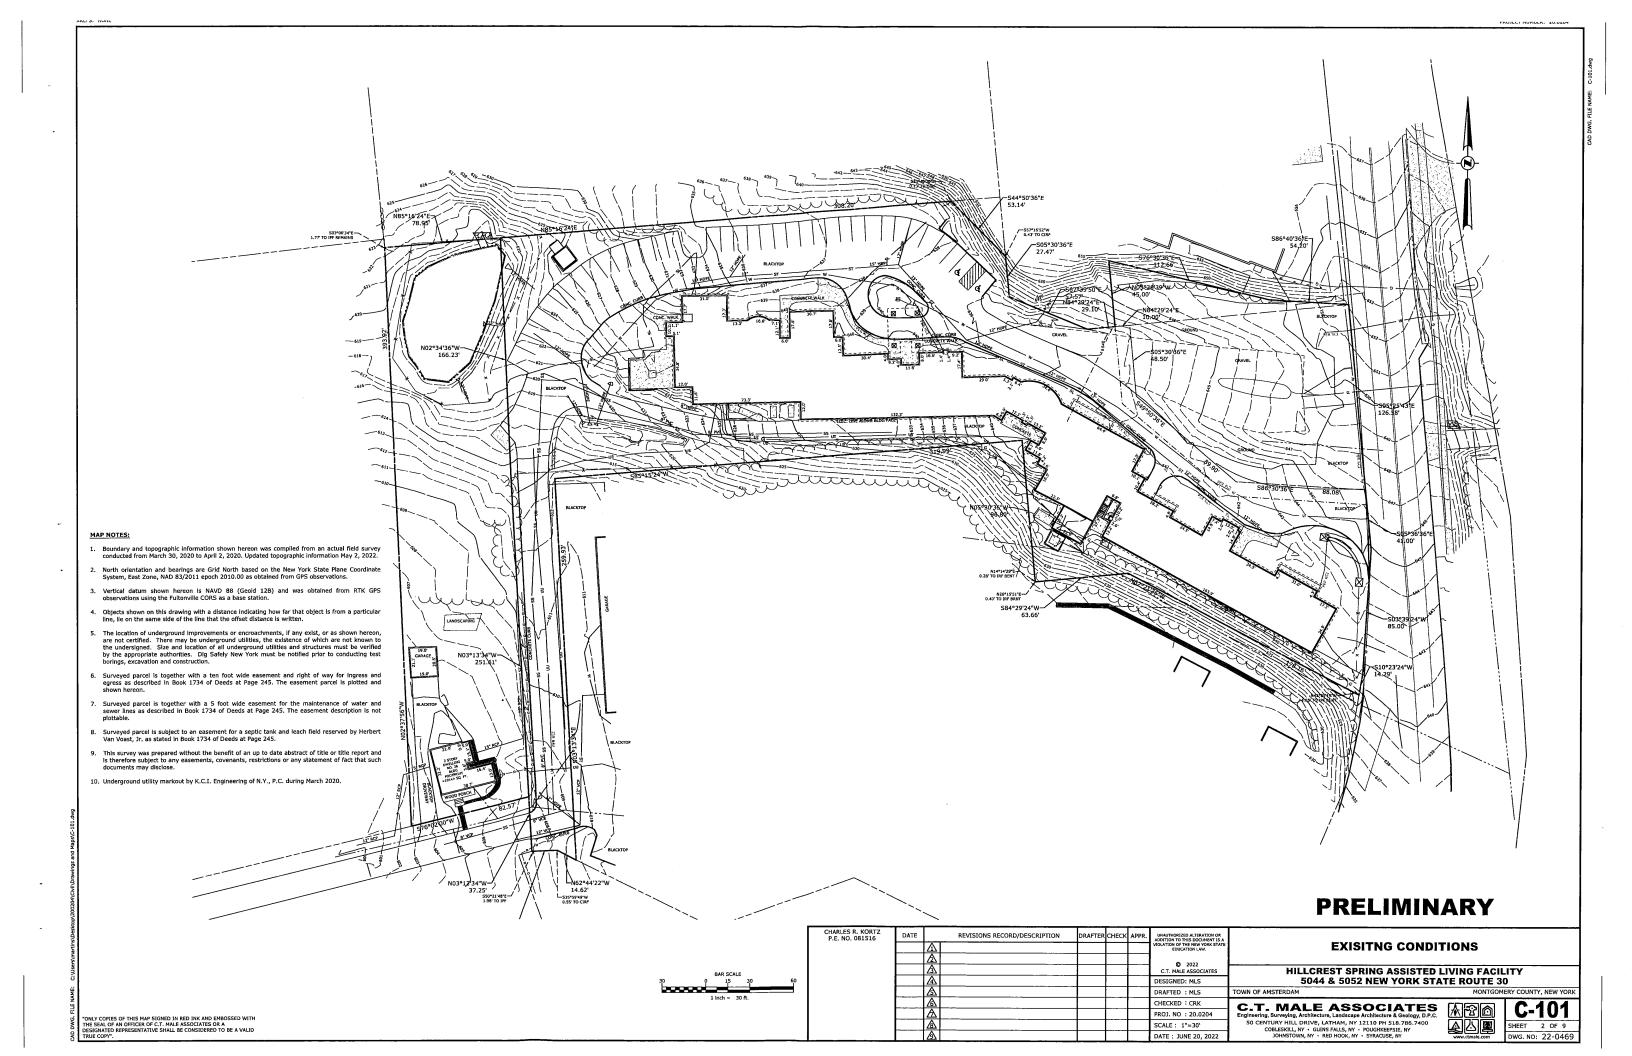


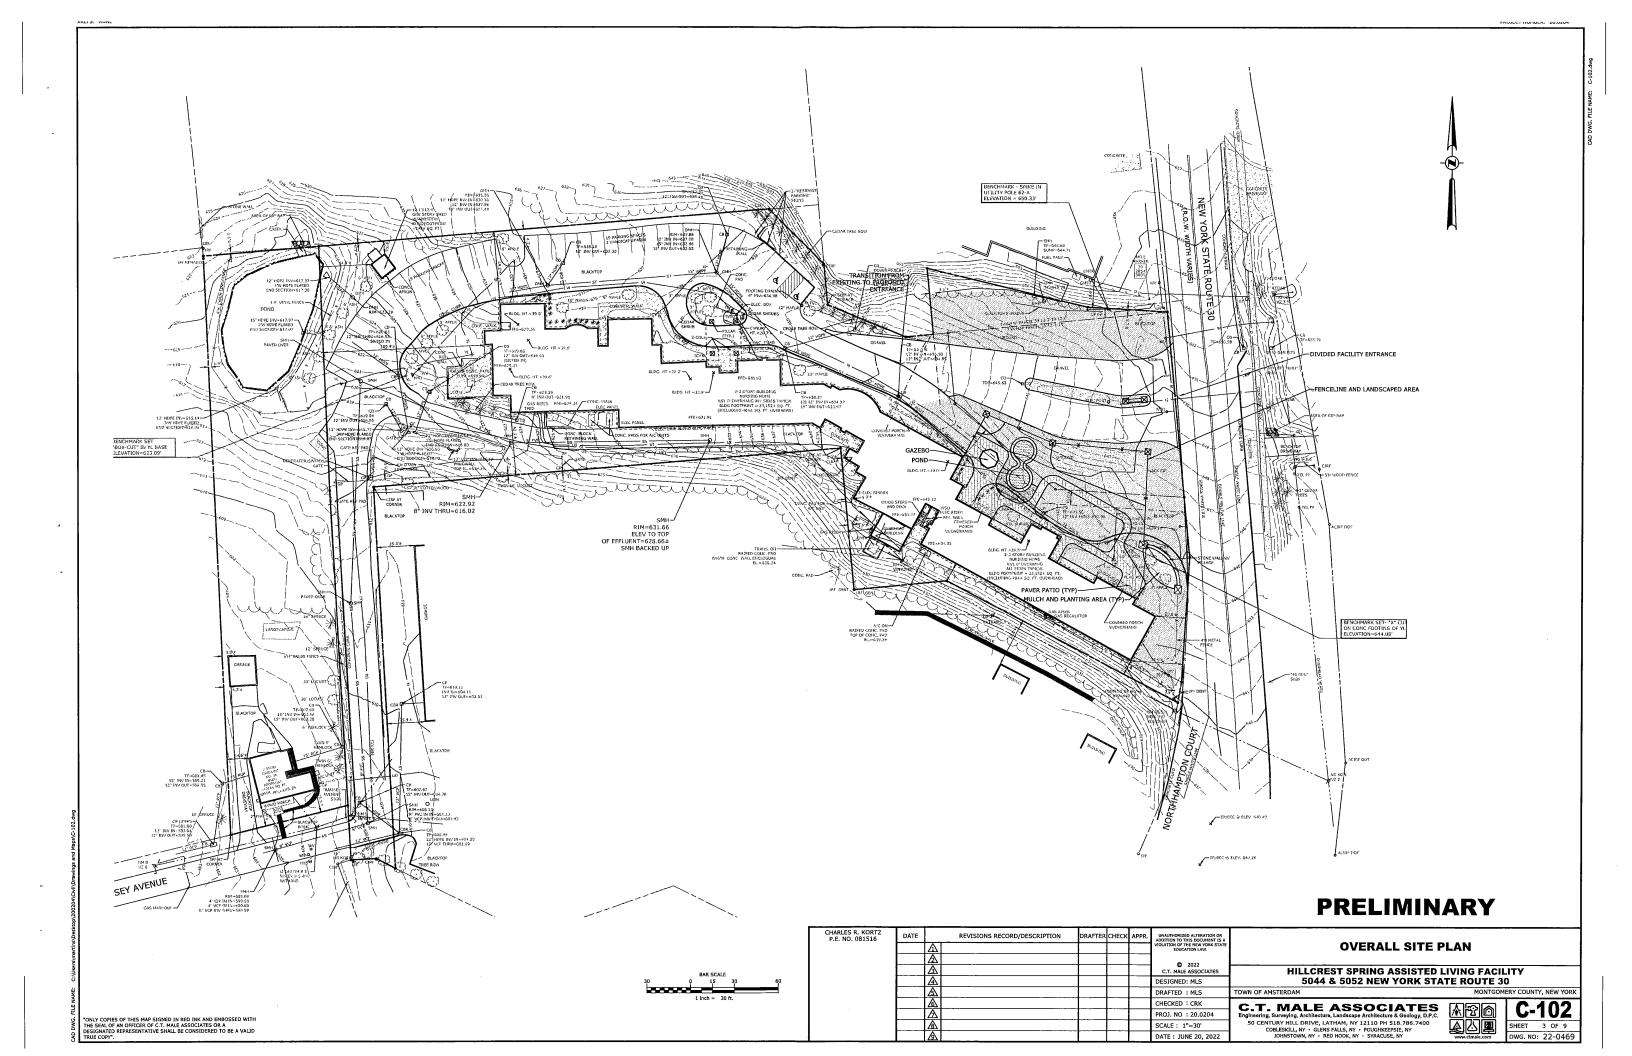

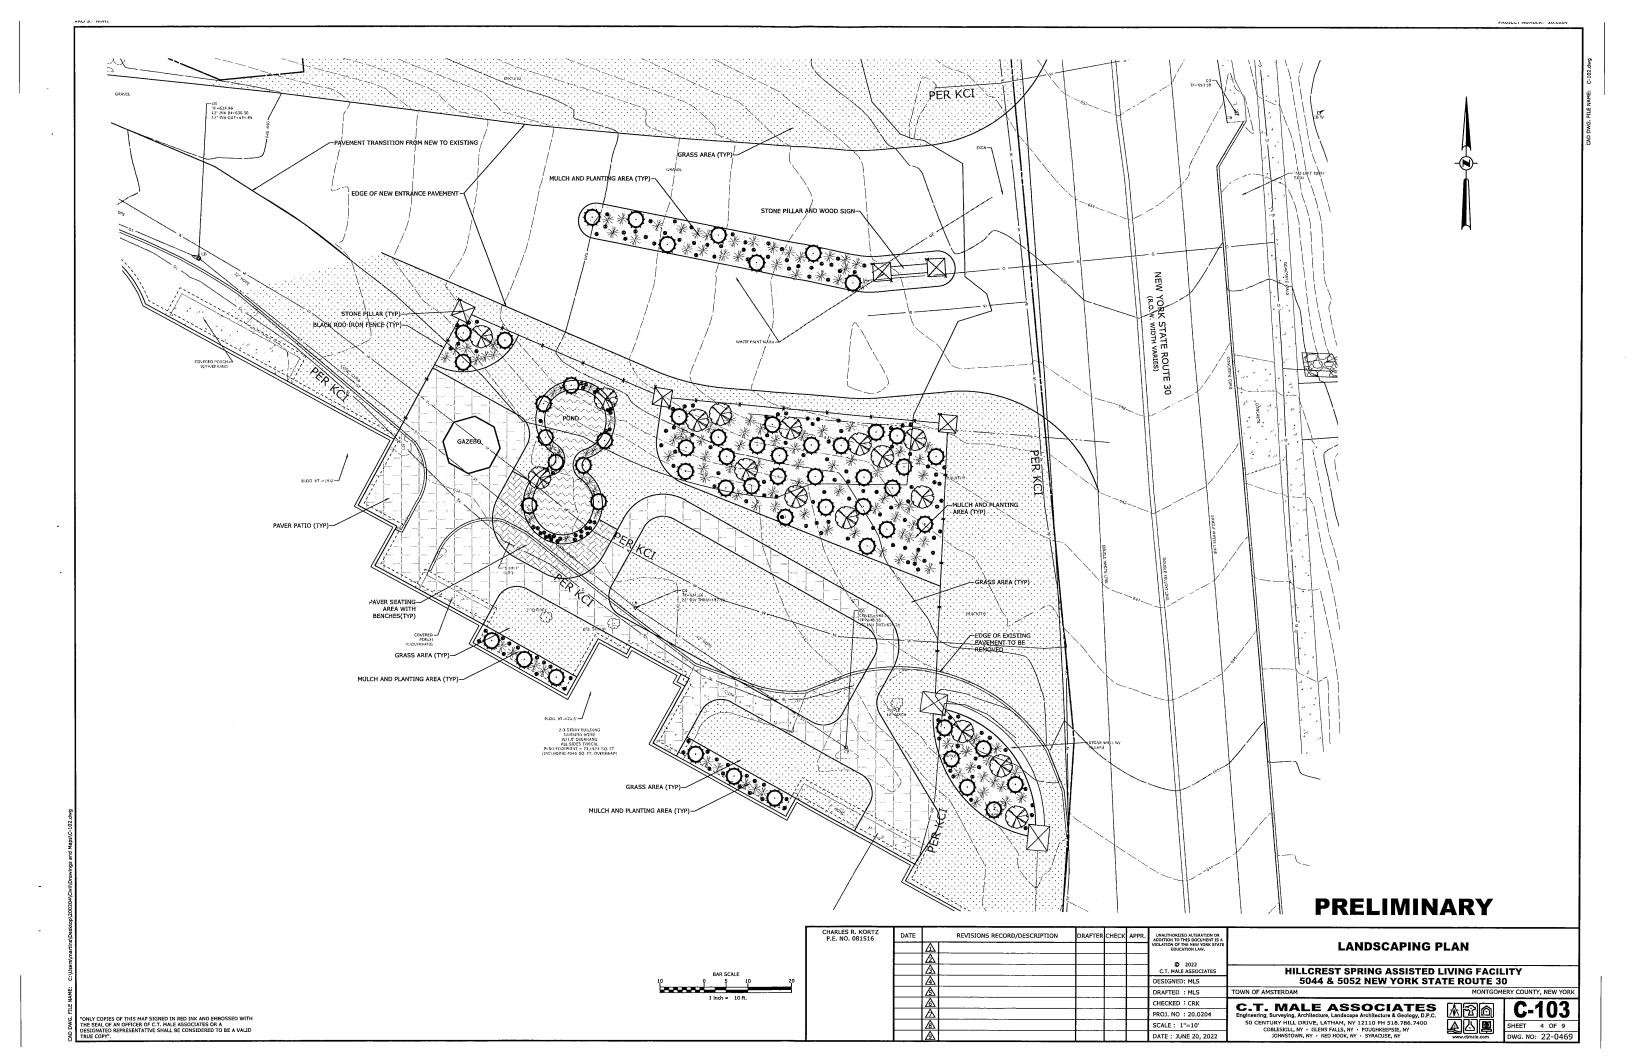

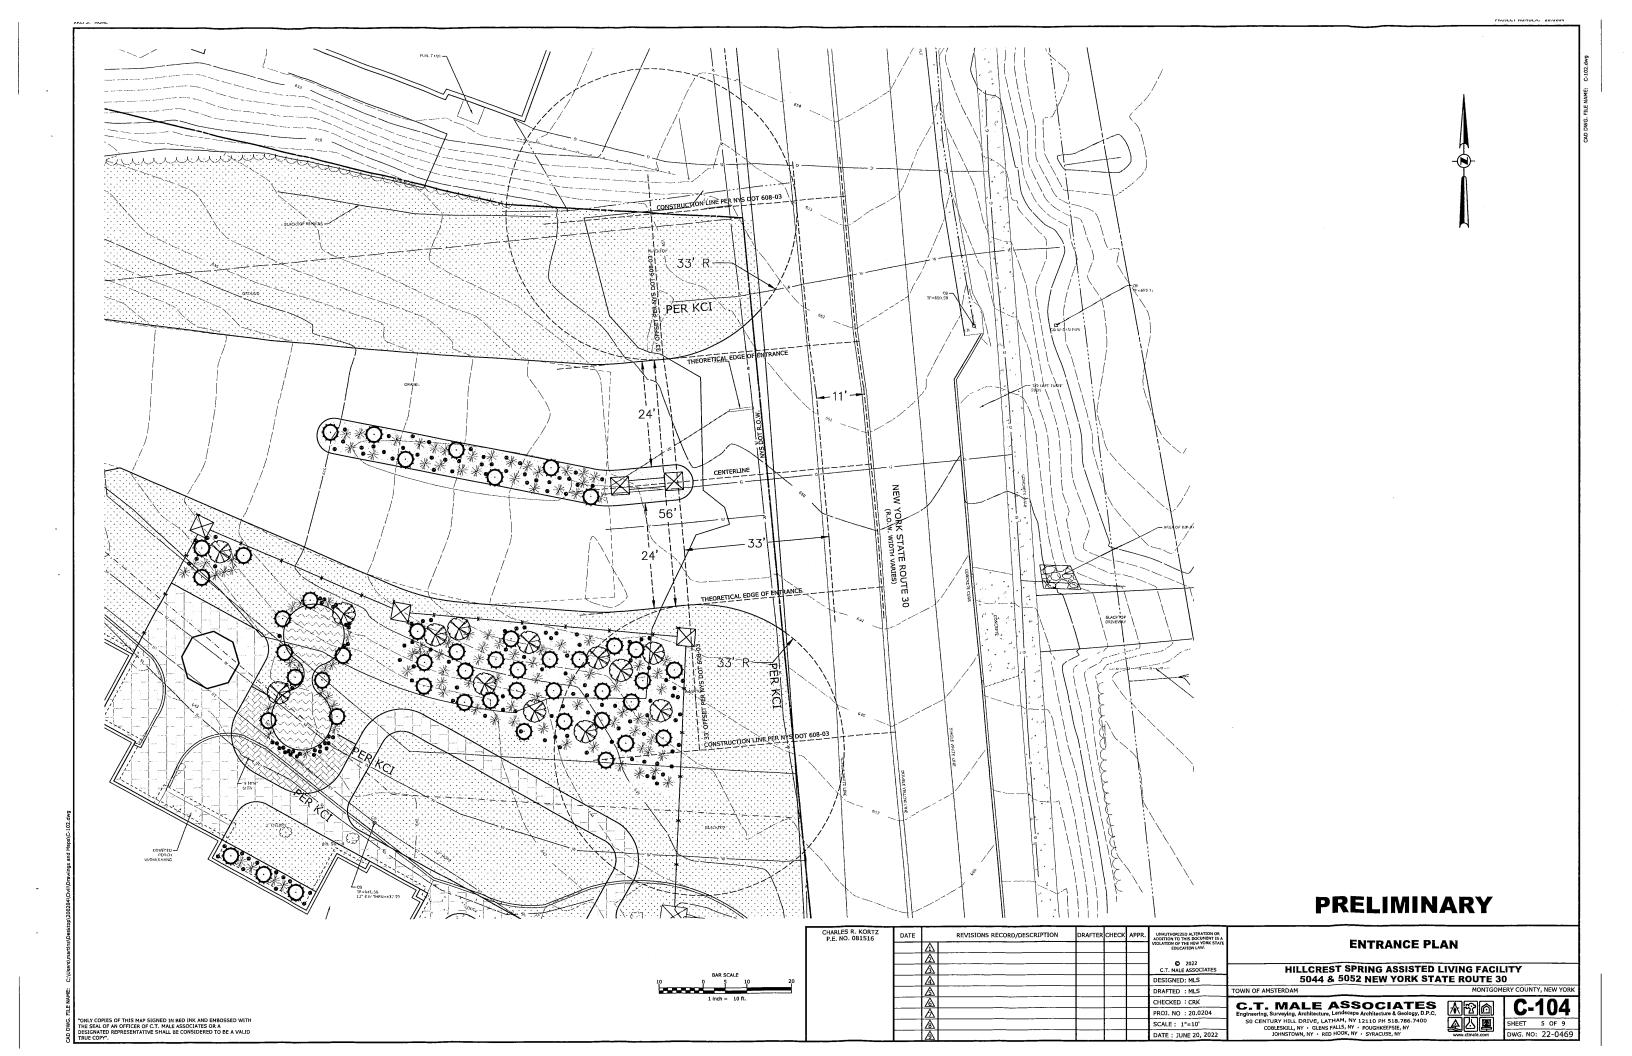


SHOULDER RECONSTRUCTION C-501 SCALE: NONE CROSS REFERENCE: NONE

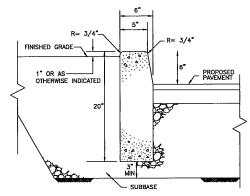

NOTE: CONCRETE SHALL HAVE A 28-DAY COMPRESSIVE STRENGTH (f'c) OF 4,000 PSI AND HAVE BETWEEN 5% AND 8% ENTRAINED AIR.

**CONCRETE CURB DETAIL** 2 CONUNL . \_ SCALE: NONE CROSS REFERENCE: NONE

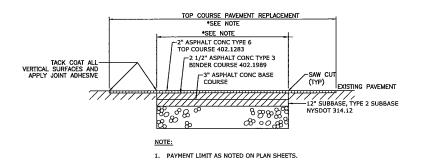

ENTRANCE PAVEMENT DETAIL C-501 SCALE: NONE CROSS REFERENCE: NONE

## **PRELIMINARY**

		UNAUTHORIZED ALTERATION OR ADDITION TO THIS DOCUMENT IS A	APPR.	CHECK	DRAFTER	REVISIONS RECORD/DESCRIPTION	DATE	CHARLES R. KORTZ P.E. NO. 081516
SITE DETAILS		VIOLATION OF THE NEW YORK STATE EDUCATION LAW.						
HILLCREST SPRING ASSISTED LIVING FACILITY	HILLCR	© 2022 C.T. MALE ASSOCIATES					A	
5044 & 5052 NEW YORK STATE ROUTE 30	5044	DESIGNED: MLS						
TOWN OF AMSTERDAM MONTGOMERY COUNTY, NEW Y	TOWN OF AMSTERDAM	DRAFTED : MLS					A	
C.T. MALE ASSOCIATES ARM C.50	CT MALE	CHECKED : CRK					(4)	
Engineering, Surveying, Architecture, Landscape Architecture & Geology, D.P.C.		PROJ. NO: 20.0204					A	
50 CENTURY HILL DRIVE, LATHAM, NY 12110 PH 518.786.7400 COBLESKILL, NY · GLENS FALLS, NY · POUGHKEEPSIE, NY SHEET 6 OF		SCALE: AS NOTED					<u>A</u>	
JOHNSTOWN, NY · RED HOOK, NY · SYRACUSE, NY www.ctmale.com DWG. NO: 22-04		DATE: JUNE 20, 2022			T		A	

"ONLY COPIES OF THIS MAP SIGNED IN RED INK AND EMBOSSED WITH THE SEAL OF AN OFFICER OF C.T. MALE ASSOCIATES OR A DESIGNATED REPRESENTATIVE SHALL BE CONSIDERED TO BE A VALID TRUE COPY".

www.ctmale.com DWG. NO: 22-0469

### SHOULDER <= $\Leftrightarrow$ $\Rightarrow$ $\Rightarrow$ SHOULDER A SHOULDER (SEE TABLE NY6H-3) TAPER (L/3 BARRIER VEHICLE SETUP (SEE NOTE 5) (SEE NOTE 8) BUFFER SPACE (SEE TABLE 6C-2 AND NOTE 2) END ROAD WORK SHOULDER WORK W21-5 NEXT XX MILES SHORT DURATION SHOULDER CLOSURE

(SEE NOTES 3 AND 6

#### LANE CLOSURE NOTES:

- WHEN A SIDE ROAD OR DRIVEWAY INTERSECTS THE ROADWAY WITHIN A WORK ZONE TRAFFIC CONTROL AREA, ADDITIONAL TEMPORARY TRAFFIC CONTROL DEVICES AND/OR FLAGGERS SHALL BE PLACED AS NEEDED. ADDITIONAL FLAGGERS SHALL BE LOCATED A ALL INTERSECTIONS AND COMMERCIAL DRIVEWAYS LOCATED WITHIN OR NEAR THE ACTIVE WORK SPACE.
- NO WORK ACTIVITY, EQUIPMENT, OR STORAGE OF VEHICLES, OR MATERIAL SHALL OCCUR WITHIN THE BUFFER SPACE AT ANY TIME. CHANNELIZING DEVICE SPACING (CENTER TO CENTER) SHALL NOT EXCEED 40' IN THE ACTIVE WORK SPACE.
- TRANSVERSE DEVICES SHALL BE REQUIRED (AS PER 619 STANDARD SPECIFICATIONS) WHEN A PAVED SHOULDER HAVING A WIDTH OF 8° OR GREATER IS CLOSED FOR ADISTANCE GREATER THAN 1500°.
- THE END ROAD WORK SIGN (G20-2) SHALL BE PLACED A MAXIMUM OF 500' PAST THE END OF THE WORK SPACE.
- . WHERE DIRECTED BY THE ENGINEER, A BUFFER SPACE SHALL BE PROVIDED IN ORDER TO LOCATE THE ONE-LANE, TWO-WAY TRAFFIC TAPER PRIOR TO ANY HORIZONTAL OR VERTICAL CURVE, IN ORDER TO PROVIDE A DEQUATE SIGHT DISTANCE FOR THE FLAGGERS AND/OR A QUEUE OF STOPPED VEHICLES.

- 8. THE FLAG TREE SHALL BE LOCATED ON THE SHOULDER, AT APPROXIMATELY 1/2 THE DISTANCE BETWEEN THE FLAGGER SIGN (W20-7a) AND THE FLAGGER.
- 10. FLAGGER AND FLAG TREE SHALL BE ILLUMINATED TO LEVEL II ILLUMINATION DURING
- NIGHT TIME OPERATIONS.

  11. ALL FLAGGERS SHALL USE 24" (MIN.) OCTAGON SHAPED STOP/SLOW PADDLES HAVING 6' STAFF.

- GENERAL TRAFFIC MAINTENANCE NOTES:
- THE MAINTENANCE AND PROTECTION PLANS SHOWN ARE STANDARDS FOR THE MOST COMMON SITUATIONS. ADDITIONAL PROTECTION SHALL BE PROVIDED WHERE SPECIAL SITUATIONS OCCUR.
- 2. THE CONTRACTOR MAY SUBMIT REVISIONS TO THIS PLAN FOR APPROVAL. BUT ANY CHANGE THAT ALTERS THE BASIC CONCEPTS OF THE PLAN MUST BE APPROVED BY THE COUNTY COMMISSIONER OF PUBLIC WORKS, OR HIS DESIGNEE.
- NO TEMPORARY LANE CLOSURES SHALL BE ALLOWED BEFORE SUNRISE OR AFTER SUNSET, OR AT OTHER TIMES WHEN VISIBILITY IS REDUCED TO LESS THAN 1000 FEET, UNLESS DIRECTED BY THE ENGINEER.
- 4. TRAVEL LANE WIDTH SHALL BE 10 FT MINUMUM AT ALL TIMES.
- 5. VEHICLES BELONGING TO THE CONTRACTOR, OR THE CONTRACTOR'S EMPLOYEES, SHALL NOT BE PARKED ON THE PAVEMENT OR SHOULDER, OR WITHIN 20 FEET OF THE EDGE OF PAVEMENT ALONG OR ADJACENT TO TRAVEL LANES OPEN TO TRAVEL, WITHIN THE PROJECT LIMITS.
- THE CONTRACTOR SHALL NOT PARK EQUIPMENT OR STORE MATERIAL OVERNIGHT WHERE IT IS DEEMED BY THE ENGINEER TO BE A
  HAZARD TO TRAFFIC.
- DRIVING AGAINST TRAFFIC AT ANY TIME, REGARDLESS OF WHETHER THE AREA HAS BEEN CLOSED TO TRAFFIC, SHALL NOT BE PERMITTED, EXCEPT FOR TRAFFIC CONE PICK-UP, AND AS SPECIFICALLY PERMITTED BY THE ENGINEER.
- 10. EXCAVATIONS THAT PRODUCE DROP-OFFS ON BOTH SIDES OF THE TRAVEL WAY AT THE SAME TIME SHALL NOT BE PERMITTED, SHOULDER AREAS SHOULD BE PREPARED TO RECEIVE THE SHOULDER PAVEMENT MATERIAL. IMMEDIATELY AHEAD OF THE SHOULDER PAVING OPERATIONS TO MINIMIZE THE TIME A DOP-OFF EXISTS. "NO SHOULDER" (W4-13C) SIGNS SHALL BE ERECTED NO MORE THAN 1200 FEET APART THROUGHOUT THE PROJECT WHERE A DOP-OFF EXIST.
- 11. THE BOTTOM OF ALL TEMPORARY CONSTRUCTION SIGNS SHALL BE A MINIMUM OF 7 FEET ABOVE THE SURFACE.
- 12. CONTRACTOR SHALL PROVIDE AND MAINTAIN SAFE AND ADEQUATE INGRESS AND EGRESS TO AND FROM HOMES AND COMMERCIAL ESTABLISHMENTS AT ALL TIMES. THE CONTRACTOR SHALL ALSO BE RESPONSIBLE FOR PROVIDING SAFE PEDESTRIAN
- 13. IF THE ENGINEER NOTIFIES THE CONTRACTOR OR HIS SUPERINTENDENT OF ANY HAZARDOUS CONSTRUCTION PRACTICES, ALL OPERATIONS IN THAT AREA SHALL BE DISCONTINUED AND IMMEDIATE REMEDIAL ACTION SHALL BE TAKEN TO THE SATISFACTION OF THE ENGINEER BEFORE WORK IS RESURBED.
- 14. IN ORDER TO MAINTAIN EFFECTIVE TRAFFIC CONTROL, THE CONTRACTOR SHALL BE RESPONSIBLE FOR MAINTENANCE OF THE TRAFFIC CONTROL. MAKING SURE ALL SIGNS, CONES, FLASHERS, DRUMS, ETC. ARE IN PLACE AND IN GOOD CONDITION. THE SOLE JUDGE OF THE EFFECTIVENESS OF THE CONTRACTOR'S EFFORTS TOWARDS THE PROTECTION OF TRAFFIC AND PERSONNEL SHALL BE THE ENGINEER'S.
- 15. FLAGGERS SHALL BE LOCATED AT ALL ACTIVE WORK AREAS AND AT OTHER LOCATIONS WITHIN A WORK AREA WHERE RESTRICTED SIGHT DISTANCE MPEDES THE FLOW OF TRAFFIC.
- IN IN THE ENGINEER'S JUDGEMENT, FLAGS ON SIGNS ARE NECESSARY DUE TO LIMITED SIGHT DISTANCE THEY SHALL BE PROVIDED BY THE CONTRACTOR.
- 18. THE WORK AREA IS TO BE CLEANED DAILY AND LEFT IN AN ACCEPTABLE MANNER,
- PEDESTRIAN AND BICYCLIST TRAFFIC SHALL BE MAINTAINED AND PROTECTED AT ALL TIMES. CONTRACTOR SHALL KEEP ONE DRIVING LANE AND ONE SIDEWALK OPEN AT ALL TIMES.

## **PRELIMINARY**

REVISIONS RECORD/DESCRIPTION C.T. MALE ASSOCIATES DESIGNED: MLS RAFTED : MLS CHECKED : CRK ROJ. NO : 20.0204 SCALE: AS NOTED DATE: JUNE 20, 2022

TRAFFIC AND MAINTENANCE CONTROLS

HILLCREST SPRING ASSISTED LIVING FACILITY **5044 & 5052 NEW YORK STATE ROUTE 30** 

C.T. MALE ASSOCIATES

C-701 SHEET 7 OF 9

DWG, NO: 22-0469

SHOULDER CLOSURE NOTES:

WHEN THE MINIMUM LANE WIDTH OF 10' CANNOT BE MAINTAINED DUE TO A SHOULDER CLOSURE, USE THE DETAIL FOR SHORT OR INTERMEDIATE TERM STATIONARY FLAGGING OPERATION.

NO WORK ACTIVITY OR STORAGE OF EQUIPMENT, VEHICLES, OR MATERIAL SHOULD OCCUR WITHIN A BUFFER SPACE.

WHEN THE DISTANCE BETWEEN THE ADVANCE WARNING SIGNS AND WORK IS 2 MILES TO 5 MILES, A SUPPLEMENTAL DISTANCE PLAQUE (W7-3a) SHOULD BE USED WITH THE SHOULDER

THE ROAD WORK NEXT XX MILES SIGN (G20-1) MAY BE USED INSTEAD OF THE ROAD WORK AHEAD SIGN (W20-1) IF WORK LOCATIONS OCCUR OVER A DISTANCE OF MORE THAN 2 MILES.

5. FOR BARRIER VEHICLE USE REQUIREMENTS SEE TABLES NY1-A AND NY2-A ON THE STANDARD SHEET TITLED "WORK ZONE TRAFFIC CONTROL LEGENDS AND NOTES".

IN SITUATIONS WHERE MULTIPLE WORK LOCATIONS EXIST WITHIN A LIMITED DISTANCE, THE DISTANCE BETWEEN THE ADVANCE WARNING SIGN AND WORK SHALL NOT EXCEED 5 MILES.

CHANNELIZING DEVICE SPACING (CENTER TO CENTER) SHALL NOT EXCEED 40' IN THE ACTIVE WORK SPACE.

8. TRANSVERSE DEVICES SHALL BE REQUIRED (AS PER 619 STANDARD SPECIFICATIONS) WHEN A PAVED SHOULDER HAVING A WIDTH OF 8' OR GREATER IS CLOSED FOR A DISTANCE GREATER TANAL 1500'.

SO CENTURY HILL DRIVE, LATHAM, NY 12110 PH 518.786.7400
COBLESKILL, NY • GLENS FALLS, NY • POUGHKEEPSIE, NY
JOHNSTOWN, NY • RED HOOK, NY • SYRACUSE, NY

OPTIONAL

OPTIONAL

1.	THE EXPOSURE CONDITIONS DESCRIBED IN TABLE NYL-A ASSUMES THERE IS NO POSITIVE PROTECTION (TEMPORARY TRAFFIC BARRIER) PRESENT. WHERE WORKERS OR HAZARDS ARE PROTECTED BY A TEMPORARY TRAFFIC BARRIER, BARRIER VEHICLES ARE NOT REQUIRED.
----	---

WHERE THE REQUIREMENT IS "OPTIONAL", EITHER A BARRIER VEHICLE OR THE STANDARD LONGITUDINAL BUFFER SPACE (TABLE 6C-2) SHALL BE PROVIDED.

NON-TRAVERSABLE HAZARD (IE. EQUIPMENT, MATERIALS, EXCAVATION) ONLY NO WORKERS EXPOSED

SHOULDER CLOSURE

- REQUIREMENTS SHALL INCLUDE PROVIDING A SEPARATE BARRIER VEHICLE FOR EACH CLOSED LANE AND EACH CLOSED PAYED SHOULDER "OR GREATER IN WIDTH. IF THE WORK SPACE MOVES WITHIN THE STATIONARY CLOSURE, THE BARRIER VEHICLE SHALL BE REPOSITIONED ACCORDINGLY, BARRIER VEHICLES PROTECTING NOTH TRANSVERSABLE HAZARDS SHALL REMAIN IN PLACE DURING BOTH WORKING AND NON-WORKING HOURS UNTIL THE HAZARD NO LONGER EXISTS. EXCEPTIONS TO THESE REQUIREMENTS MAY BE MADE, AS APPROVED BY THE COUNTY COMMISSIONER OF PUBLIC WORKS OR HIS/HER DESIGNEE.
  WHERE BARRIER VEHICLE PLACEMENT WOULD BE INEFFECTIVE OR WOULD INTERFERE WITH THE SAFE OPERATION OF TRAFFIC.
- BARRIER VEHICLES ARE NOT REQUIRED FOR MILLING AND/OR PAVING OPERATIONS, BUT THE STANDARD LONGITUDINAL BUFFER SPACE (TABLE 6C-2) SHALL BE PROVIDED.
- BARRIER VEHICLES ARE NOT REQUIRED FOR FLAGGING OPERATIONS, BUT THE STANDARD LONGITUDINAL BUFFER SPACE (TABLE6C-2) SHALL BE PROVIDED.

	SHADOW VEHICLE	E NY1-B USE REQUIREMENTS CLOSURES)					
			USE REQUIRE	MENTS			
CLOSURE TYPE	EXPOSURE CONDITION	FREEWAY	NON-FREEWAY (PRECONSTRUCT	AY UUCTION POSTED SPEED LIMIT)			
		PREEWAT	≥ 45 MPH	35-40 MPH	≤ 30 MPH		
LANE CLOSURE	WHEN ANY WORKER, VEHICLE, OR OTHER HAZARD IS EXPOSED TO TRAFFIC	REQUIRED 2,4	REQUIRED 2,4	REQUIRED 2,4	REQUIRED 2		
SHOULDER CLOSURE	WHEN ANY WORKER, VEHICLE, OR OTHER HAZARD IS EXPOSED TO TRAFFIC	REQUIRED 2,4	REQUIRED 2,4	REQUIRED 2,4	REQUIRED 2		

- A MOBILE CLOSURE SHALL BE USED FOR ANY WORK ACTIVITY THAT MOVES CONTINUOUSLY OR INTERNITTENTLY ALONG THE TRAVELED WAY OR SHOULDER SLOWER THAN THE PREVAILING SPEED OF TRAFFIC. CHANNELIZING DEVICES ARE NOT USED FOR MOBILE CLOSURES.
- SHADOW VEHICLES SHALL BE EQUIPPED WITH AN APPROVED REAR MOUNTED ATTENUATOR (TRUCK MOUNTED OR TRAILER MOUNTED) FOR THE FOLLOWING MOBILE CLOSURES: LANG CLOSURES ON FREEWAYS, LANG CLOSURES ON NON-REEWAY ROADWAYS HAWING A PRE-CONSTRUCTION POSTED SPEED LIMIT OF 3 SIMPL OR MORE, SHOULDER CLOSURES ON FREEWAYS, AND SHOULDER CLOSURES ON NON-REEWAY ROADWAYS HAVING A PRE-CONSTRUCTION SPEED LIMIT OF 45 HIM FOR MORE.
- A SHADOW VEHICLE IS USED TO PROTECT EXPOSED WORKERS (ON FOOT OR IN A VEHICLE) AND SHALL BE REQUIRED FOR ALL MOBILE CLOSURES. SHADOW VEHICLE REQUIREMENTS SHALL INCLUDE PROVIDING A SEPARATE SHADOW VEHICLE FOR EACH CLOSED LANCE SHADOW OF REACH CLOSED LANCE SHADOW OF REACH CLOSED LANCE SHADOW LOSED AND SHADOW OF REACH CLOSED LANCE SHADOW LOSED AND SHADOW VEHICLES MAY BE REQUIRED TO PROMOTE THE SAFE OPERATION OF TRAFFIC AND THE INCREASED PROTECTION OF EXPOSED WORKERS, AS DIRECTED BY THE COUNTY COMMISSIONER OF PUBLIC WORKS OR HIS/HER DESIGNEE.

_		т	ABLE 6H-4 FC	ORMULAS FOR	DETERMININ	IG TAPER LEA	ICTHS	-		
SPEED LIMIT	(S)	TAP (FT.	ER LENGTH (I	L)						
(40 MPH) OR	LESS	L =	ws /60		W = 1	TAPER LENGT WIDTH OF OF PRECONSTRU	H FSET (FT.) CTION POSTE	D SPEED LIM	ІТ (МРН)	
(45 MPH) OR	MORE	L=	ws							
				STANDARD	TAPER LENGT	HS				
LATERAL SHIFT OF TRAFFIC		TEM	PORARY TRAF	FIC CONTROL	ZONE POSTE	D SPEED LIM	п			
FLOW PATH	(25 MPH)	(30 MPH)	(35 MPH)	(40 MPH)	(45 MPH)	(50 MPH)	(55 MPH)	(60 MPH)	(65 MPH)	(70 MPH)
4	45	60	85	110	180	200	220	240	260	280
5	55	75	105	135	225	250	275	300	325	350
6	65	90	125	160	270	300	330	360	390	420
7	75	105	145	190	315	350	385	420	455	490
8	85	120	165	215	360	400	440	480	520	560
9	95	135	185	240	405	450	495	540	585	630
10	105	150	205	270	450	500	550	600	650	700
11	115	165	225	295	495	550	605	660	715	770
12	125	180	245	320	540	600	660	720	780	840

TYPE OF TAPER	TAPER LENGTH (L
HERGING TAPER	L
HIFTING TAPER	L/2
HOULDER TAPER	L/3
NE-LANE, TWO-WAY TRAFFIC TAPER	100 FT. MAXIMUM
DWNSTREAM TAPER	100 FT. PER LANE

	TABLE 6C-2 DINAL BUFFER SPACE
PRECONSTRUCTION POSTED SPEED LIMIT (MPH)	DISTANCE
25	155 FT.
30	200 FT.
35	250 FT.
40	305 FT.
45	360 FT.
50	425 FT.
55	495 FT.
60	570 FT.
65	645 FT.

ı	T PLACEMENT DISTA	ABLE NYZ-A NCE FOR BARRIEF	R VEHICLES				
PRECONSTRUCTION	PLACEMENT DISTANCE (FT.)						
POSTED SPEED LIMIT	BARRIER VEHICLES*						
(MPH)	(18000 L	BS.)	(24000	LBS.)			
	MINIMUM	MAXIMUM	MUMINIM	MUMIXAM			
> 55	100 FT.	200 FT.	100 FT.	200 FT.			
45 - 55	100 FT.	200 FT.	85 FT.	165 FT.			
< 45	85 FT.	165 FT.	50 FT.	100 FT.			

\* AS DEFINED IN NYSDOT STANDARD SPECIFICATION 619-BARRIER VEHICLE - VEHICLE USED FOR STATIONARY SHOULDER CLOSURES, LANE CLOSURES, AND OTHER STATIONARY WORK ZONES. MINIMUM DISTANCE SHOWN REFLECTS THE ACTUAL ROLL AHEAD DISTANCE FROM MANUFACTURER.

	TABLE NY2-B LACEMENT DISTANCE FOR SHADOW VEHICLES					
PRECONSTRUCTION		PLACEMENT DISTANCE (FT.)				
POSTED SPEED LIMIT		SHADOW VEHICLES**				
(MPH)	(18000 L	BS.)	(24000	4000 LBS.)		
	MINIMUM	MUMIXAM	MINIMUM	MAXIMUM		
> 55	230 FT.	330 FT.	180 FT.	280 FT.		
45 - 55	180 FT.	180 FT. 280 FT. 150 FT.				
< 45	100 FT.	200 FT.	100 FT.	200 FT.		

SHADOW VEHICLE - VEHICLE USED FOR MOBILE OR SHORT DURATION WORK OPERATIONS.

MINIMUM DISTANCE SHOWN REFLECTS THE ACTUAL ROLL AHEAD DISTANCE FROM MANUFACTURER.

TABLE 619-4 Flare rates for positi					
	1	POSTED	SPEED L	MIT	
TYPE OF POSITIVE BARRIER	30 MPH	40 MPH	50 MPH	55 MPH	65 MPH
TEMPORARY CONCRETE BARRIER	8:1	11;1	14;1	16;1	20:1
BOX BEAM OR HEAVY POST CORRUGATED BEAM	7:1	9:1	11;1	12:1	15:1

	TABU ADVANCE WARN	E NY6H-3 ING SIGN SPACI	NG		
	DISTANCE	BETWEEN S	IGNS	SIGN L	EGEND
ROAD TYPE	A (FT.)	B (FT.)	C (FT.)	xx	YY
URBAN (≤ 30 MPH+)	100	100	100	AHEAD	AHEAD
URBAN (35-40 MPH*)	200	200	200	AHEAD	AHEAD
URBAN (≥ 45 MPH+)	350	350	350	1000 FT.	AHEAD
RURAL	500	500	500	1500 FT.	1000 FT.
EXPRESSWAY / FREEWAY	1000	1500	2640	1 MILE	K MILE

\* PRECONSTRUCTION POSTED SPEED LIMIT

URBAN: (MEETS MORE THAN 1 OF THE FOLLOWING CRITERIA) SIDEWALKS, BICYCLE USAGE, CURBING, CLOSED DRAINAGE SYSTEMS, DRIVEWAY DENSITIES GREATER THAN 2 4 DRIVEWAYS PER MILE, MINOR COMMERCIAL DRIVEWAY DENSITIES OF 10 DRIVEWAYS PER MILE OR GREATER, MOAN COMMERCIAL DRIVEWAYS, MUNEROUS RIGHT OF MAY CONSTRAINTS, HIGH DENSITY OF CROSS STREETS, 85TH PERCENTILE SPEEDS OF 45 MHO NE LESS.

RURAL: ANY AREA NOT EXHIBITING MORE THAN ONE OF THE ABOVE CHARACTERISTICS.

FREEWAYS/INTERSTATE: LOCAL OR INTER REGIONAL HIGH-SPEED, DIVIDED, HIGH-VOLUME FACILITIES WITH FULL OR PARTIAL CONTROL OF ACCESS.

WORK DURATION DEFINITIONS
ONG-TERM STATIONARY IS WORK THAT OCCUPIES A LOCATION MORE THAN 3 CONSECUTIVE DAYS.
NTERMEDIATE-TERM STATIONARY IS WORK THAT OCCUPIES A LOCATION HORE THAN ONE DAYLIGHT PERIOD UP TO 3 CONSECUTIVE DAYS, OR HIGHTIME WORK LASTING MORE THAN 1 HOUR.
SHORT-TERM STATIONARY IS DAYTIME WORK THAT OCCUPIES A LOCATION FOR MORE THAN 1 HOUR WITHIN A SINGLE DAYLIGHT PERIOD.
SHORT DURATION IS WORK THAT OCCUPIES A LOCATION UP TO 1 HOUR.
HOBILE IS WORK THAT MOVES INTERMITTENTLY OR CONTINUOUSLY,

	WORK ZONE TRAFFIC CONTROL LEGEND
SYMBOL	DESCRIPTION
·	ARROW PANEL
	ARROW PANEL, CAUTION MODE
888	ARROW PANEL TRAILER OR SUPPORT
$\vdash$	CHANGEABLE MESSAGE SIGN (PVMS)
	CHANNELIZING DEVICE
	CRASH CUSHION/TEMPORARY IMPACT ATTENUATOR
<b>L</b> →	DIRECTION OF TEMPORARY TRAFFIC DETOUR
4>	DIRECTION OF TRAFFIC
<b>—</b>	FLAGGER
**	FLAG TREE
•	LUMINAIRE
11111	PAVEMENT MARKINGS THAT SHALL BE REMOVED FOR A LONG TERM PROJECT
-	SIGN, TEMPORARY
	TEMPORARY BARRIER
	TEMPORARY BARRIER WITH WARNING LIGHTS
O <b>&gt;</b>	TRAFFIC OR PEDESTRIAN SIGNAL
833	TYPE III BARRICADE
മ	WARNING LIGHTS
	WORK SPACE
	WORK VEHICLE
	WORK VEHICLE WITH TRUCK MOUNTED ATTENUATOR

TEMPORARY LAME/SHOULDER CLOSURE RESTRICTIONS FOR HOLIDAYS 2022						
HOLIDAY	FALLS ON	TEMPORARY LAND CLOSURES ARE NOT ALLOWED FROM				
NEW YEAR'S DAY	SATURDAY JANUARY 1	BEGINNING 6 AM THURSDAY DECEMBER 30, 2021, AND ENDING 6 AM MONDAY JANUARY 3, 2022				
MEMORIAL DAY	MONDAY MAY 30	BEGINNING 6 AM FRIDAY MAY 27, 2022, AND ENDING 6 AM TUESDAY MAY 31, 2022				
INDEPENDENCE DAY	MONDAY JULY 4	BEGINNING 6 AM FRIDAY JULY 1, 2022, AND ENDING 6 AM TUESDAY JULY 5, 2022				
LABOR DAY	MONDAY SEPTEMBER 5	BEGINNING 6 AM FRIDAY SEPTEMBER 2, 2022, AND ENDING 6 AM TUESDAY SEPTEMBER 6, 2022				
THANKSGIVING DAY	THURSDAY NOVEMBER 24	BEGINNING 6 AM WEDNESDAY NOVEMBER 24, 2022, AND ENDING 6 AM MONDAY NOVEMBER 28, 2022				
CHRISTMAS DAY	SUNDAY DECEMBER 25	BEGINNING 6 AM FRIDAY DECEMBER 23, 2022, AND ENDING 6 AM TUESDAY DECEMBER 27, 2022				

## **PRELIMINARY**

REVISIONS RECORD/DESCRIPTION C.T. MALE ASSOCIATES DESIGNED: MLS CHECKED : CRK PROJ. NO : 20.0204 SCALE: AS NOTED DATE: JUNE 20, 2022

TRAFFIC AND MAINTENANCE CONTROLS

HILLCREST SPRING ASSISTED LIVING FACILITY **5044 & 5052 NEW YORK STATE ROUTE 30** 

C.T. MALE ASSOCIATES ngineering, Surveying, Architecture, Landscape Architecture & Geology, D.P.1 50 CENTURY HILL DRIVE, LATHAM, NY 12110 PH 518.786.7400 COBLESKILI, NY - GENS FALLS, NY - POUGHKERESIE, NY JOHNSTOWN, NY - RED HOOK, NY - SYRACUSE, NY

C-702 SHEET 8 OF 9 DWG. NO: 22-0469

WORK ZONE TRAFFIC CONTROL SIGN TABLE								
SIGN	M.U.T.C.D. CODE	COLOR	CONVENTIONAL ROAD*	EXPRESSWAY	FREEWAY			
30 MPH	W13-1	A	24"X24"	24"X24"	24"X24"			
<b>—</b>	W1-6L	<b>A</b>	48"X24"	48°X24*	48"X24"			
<b></b>	W1-6R	A	40 824	40 324	40 AZ4			
	W1-BL	A						
	W1-8R	A	- 36°X48*	36"X48"	36°X48°			

WORK ZONE TRAFFIC CONTROL SIGN TABLE						
SIGN	M.U.T.C.D. CODE	COLOR	CONVENTIONAL ROAD*	EXPRESSWAY	FREEWAY	
ROAD WORK NEXTXMLES	G20-1	Α	36"X18"	42°XZ4°	42"X24"	
END ROAD WORK	G20-2	A	36"X18"	4Z*X24*	42°X24"	
STATE EAVI LODRE SUPPORTED AFTERINO WORKZDE SYSTEMS TIDEES	NYR9-11	В	24*X42*	48*X84**	48*X84*	
	W20-7a	A	36"X36"	48"X48"	48"X48"	
	W21-1a	A	36*X36*	48"X48"	48"X48"	
SHOULDER	W21-5	A	30"X30"	48*X48"	48"X48"	
ROAD WORK XXXFT ROAD WORK XXXFT	W20-1	A	36"X36"	48"X48"	48"X48"	
ORELINE ROND AFFEAD OPELINE ROAD DOORFT XMILE	W20-4	A	36"X36"	48"X48"	48"X48"	
NEXT X MILES	W7-3a	A	24"X18"	24"X18"	24"X18"	
CENTERLANE CLOSED AEED RECHTLANE RECHTLANE	wzo-5	A	36"X36"	48"X48"	48"X48 <b>"</b>	

W21-5bL

36"X36"

48"X48"

WORK ZONE TRAFFIC CONTROL SIGN TABLE

GENERAL NOTES:

ALL SIGN, CONES, BARRELS, BARRICADES AND CONC BARRIERS SHALL BE FABRICATED AND ERECTED IN ACCORDANCE WITH THE CONTRACT PLANS AND SPECIFICATIONS OR AS DIRECTED BY THE NEW YORK STATE MANUAL OF UNIFORM TRAFFIC CONTROL DEVICES 1. GENERAL:

2. SIGN SUPPORT:

THE CONTRACTOR SHALL SUPPLY ADEQUATE SUPPORTS SO THAT THE SIGNS ARE IN PROPER POSITION AND ALIGNMENT AS SHOWN IN THE NEW YORK STATE MANUAL OF UNIFORM TRAFFIC CONTROL DEVICES, ALL SUPPORTS SHALL BE PAINTED WITH TWO(2) COATS

3. SIGN PANELS: THE SIGN PANELS MAY BE MADE OF ALUMINUM, STEEL, OR PLYWOOD THE BACKS OF ALL WOOD SIGN PANELS SHALL RECEIVE TWO(2) COATS OF WHITE PAINT.

COATS OF WHITE PAINT.

COLOR\_THE COLOR OF THE BACKGROUND AND THE LEGEND OF ALL
SIGNS SHALL BE IN ACCORDANCE WITH THE NEW YORK STATE
MANUAL OF UNIFORM TRAFFIC CONTROL DEVICES. THE MARGIN SHALL BE
OF THE SAME COLOR AS SPECIFIED FOR THE BACKGROUND. THE BORDER
SHALL BE OF THE SAME COLOR AS THE LEGEND.
SHAPE\_THE SHAPE OF ALL SIGNS SHALL BE AS SHOWN ON THIS SHEET.
CORNERS OF SIGNS SHALL BE AS SHOWN ON THIS SHEET.
CORNERS OF SIGNS SHALL BE AREFLECTORIZED USING
HIGH INTENSITY REFLECTORIZED TAPE OR PAINT. ALL SIGNS
SHALL BE CLEAMED AND MAINTAINED REQUIABLY. ALL SIGNS SHALL
BE REVIEWED AT NIGHT AFTER ERECTION. ANY SIGNS NOT MEETING
PROPER REFLECTION REQUIREMENTS WILL BE REPLACED.
LETTERING AND BORDERS—SIGN LETTERING, BORDERS AND
MARGINS SHALL BE IN ACCORDANCE WITH THE NEW YORK STATE MANUAL
OF UNIFORM TRAFFIC CONTROL DEVICES.

5. SIGN LOCATION:

SIGNS SHALL BE GENERALLY LOCATED ON THE RIGHT SIDE OF THE HIGHWAY FACING APPROACHING TRAFFIC. THE NEAR EDGE OF THE SIGN SHALL BE BETWEEN 6 AND 12 FEET FROM NEAREST EDGE OF THE TRAVELED ROADWAY OR BETWEEN 2 AND 12 FEET FROM THE FACE OF THE VERTICAL CURB. SIGNS SHOULD GENERALLY BE FLACED AT RIGHT ANGLES TO TRAFFIC. ROADSIDE SIGNS SHOULD BE MOUNTED SO THAT THE BOTTOM OF THE SIGN IS APPOXIMATELY 5 FEET ABOVE THE EDGE OF PAVEMENT. SIGNS MOUNTED ON BARRICADES ON TEMPORARY SIGNS IN THE ROADWAY MAY BE AT LOWER HEIGHTS, ALL SIGNS SHALL BE LOCATED SO AS TO BE PLAINLY VISIBLE TO TRAFFIC.

6. MAINTENANCE:

THE CONTRACTOR SHALL KEEP SIGNS CLEANED AND CLEARED AT ALL TIMES. ALL SIGNS SHALL BE THE PROPERTY OF THE CONTRACTOR AND SHALL BE MAINTAINED IN GOOD CONDITION FOR THE DURATION OF THE CONTRACT. ALL SIGNS SHALL BE REMOVED FROM THE WORK SITE WHEN THE CONTRACT WORK IS ACCEPTED.

	COLOR CODE LEGEND
CODE	DESCRIPTION
٨	BLACK LEGEND AND BORDER ON A ORANGE BACKGROUND
8	BLACK LEGEND AND BORDER ON A WHITE BACKGROUND
c	WHITE LEGEND AND BORDER ON A GREEN BACKGROUND
D	WHITE LEGEND AND BORDER ON A RED BACKGROUND
E	RED LEGEND AND BORDER ON A WHITE BACKGROUND
F	BLACK LEGEND AND BORDER ON A FLORESCENT VELLOW GREEN BACKGROUND

## **PRELIMINARY**

	CHARLES R. KORTZ P.E. NO. 081516	DATE		REVISIONS RECORD/DESCRIPTION	DRAFTER	CHECK	APPR.	ADDITION TO THIS DOCUMENT IS A	
Ì			$ \Lambda $					VIOLATION OF THE NEW YORK STATE EDUCATION LAW.	ŀ
			$\Delta$					Ø 2022	
			◬					C.T. MALE ASSOCIATES	
			A					DESIGNED: MLS	
			A					DRAFTED : MLS	TOWN
			<u>A</u>					CHECKED : CRK	C.
			$\triangle$					PROJ. NO : 20.0204	Engin
			$\triangle$		T			SCALE: AS NOTED	50
								DATE: 1UNE 20, 2022	

TRAFFIC AND MAINTENANCE CONTROLS

HILLCREST SPRING ASSISTED LIVING FACILITY **5044 & 5052 NEW YORK STATE ROUTE 30** 

gineering, Surveying, Architecture, Landscape Architecture & Geology, D.P.C.
50 CENTURY HILL DRIVE, LATHAN, NY 12110 PH 518.786.7400
COBLEXILL, NY GENER FALLS, NY - DOLIGHKEPSIE, NY
JOHNSTOWN, NY - RED HOOK, NY - SYRACUSE, NY

C-703 SHEET 9 OF 9 DWG. NO: 22-0469

"ONLY COPIES OF THIS MAP SIGNED IN RED INK AND EMBOSSED WITH THE SEAL OF AN OFFICER OF C.T. MALE ASSOCIATES OR A DESIGNATED REPRESENTATIVE SHALL BE CONSIDERED TO BE A VALID TRUE COPP".